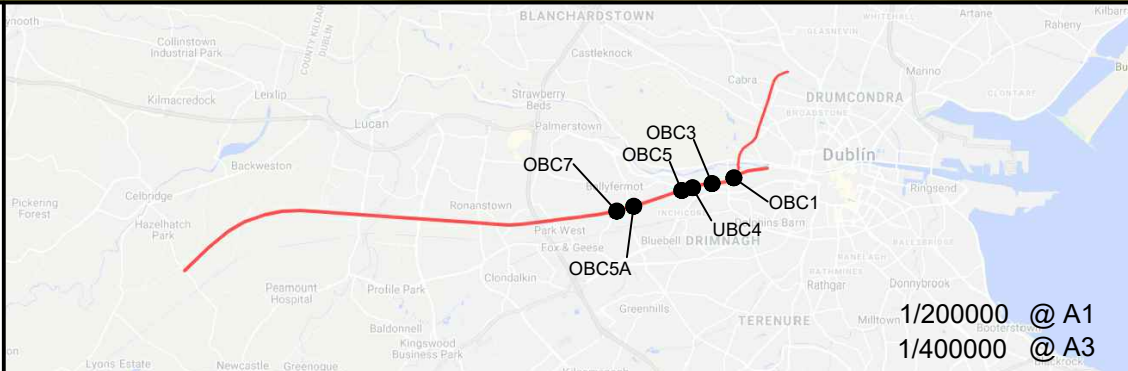


LEGEND :-
----- IRISH RAIL PROPERTY
BOUNDARY

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Rev	Date	Dm	Chk'd	App'd	Description
v01	29/10/21	AOS	RM	AG	ISSUED FOR PUBLIC CONSULTATION 2


Client Iarnród Éireann Irish Rail	
Date 06/09/21	Scale 1:100 @ A1 1:200 @ A3
Project Code 5199586	Issuer TTA


Engineering Designer ATKINS Member of the SNC-Lavalin Group Supported by: rps	
Drawn AOS	Checked RM
Approved AG	QMS Code

Project Title DART + SOUTH WEST	
Drawing Title SARSFIELD ROAD BRIDGE (UBC4) GENERAL ARRANGEMENT	
Drawing File Name DP-04-23-DWG-ST-TTA-57140	Version v01
Status S3	

DO NOT SCALE USE FIGURED DIMENSIONS ONLY



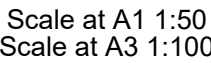

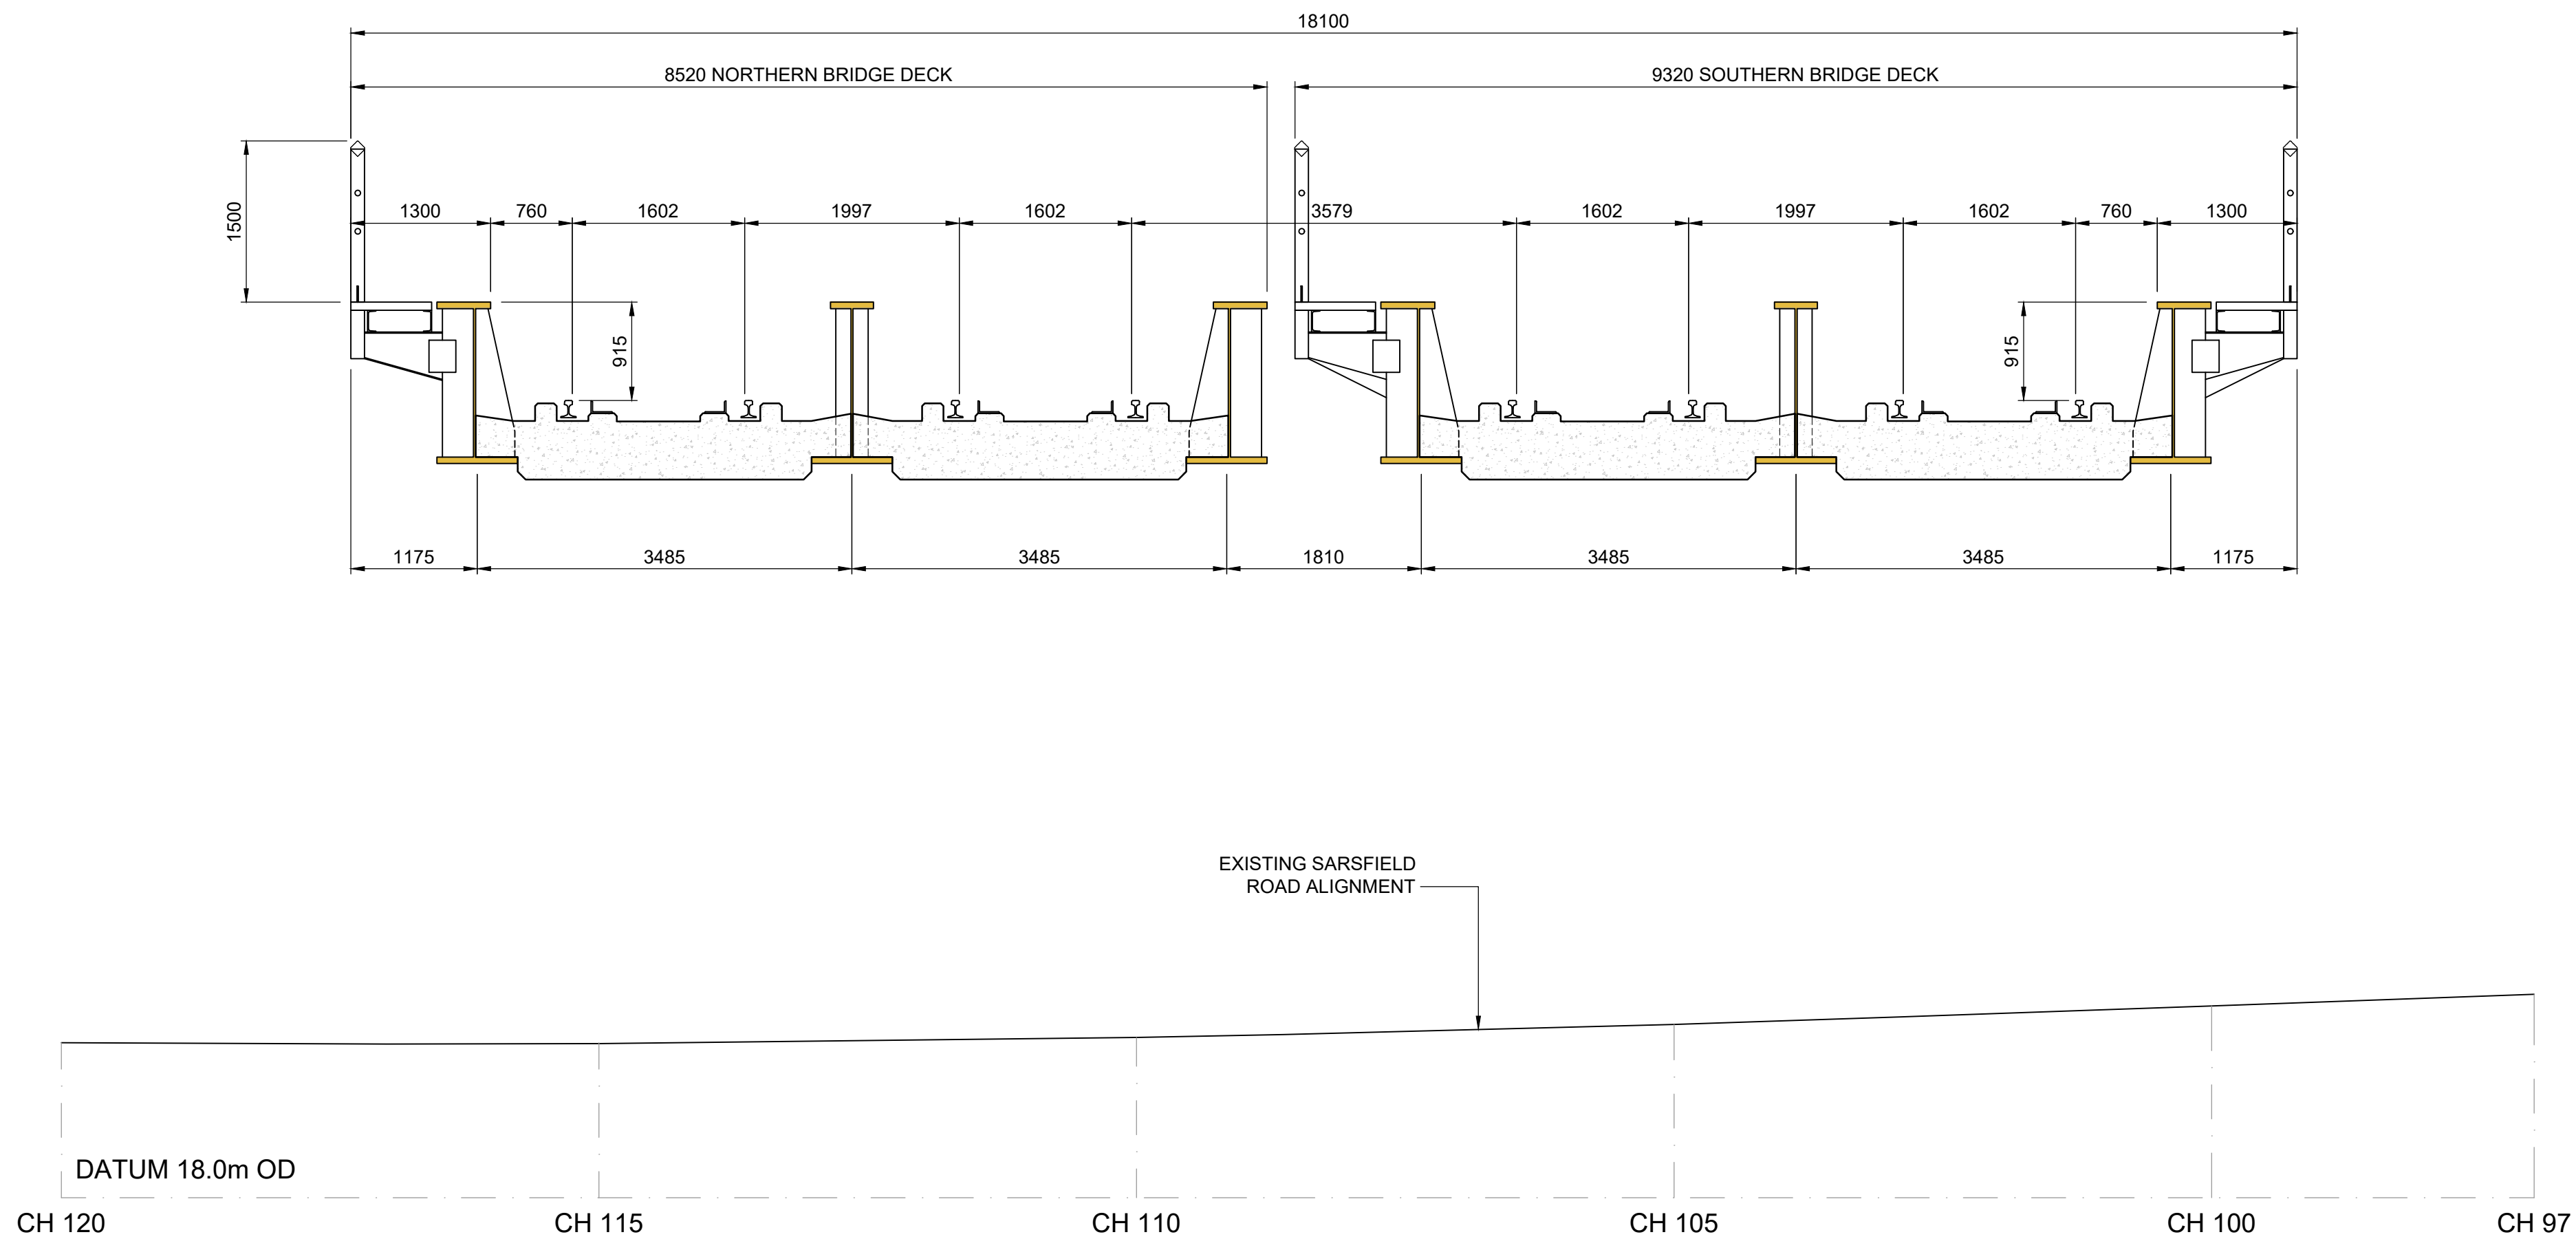


BRIDGE DECKS CROSS SECTIONS

Scale at A1 1:50
Scale at A3 1:100

V:\5199586 Cork\6 Dwg-Graphics\61 AutoCad\PC2\DP-04-23-DWG-ST-TTA-57144.dwg

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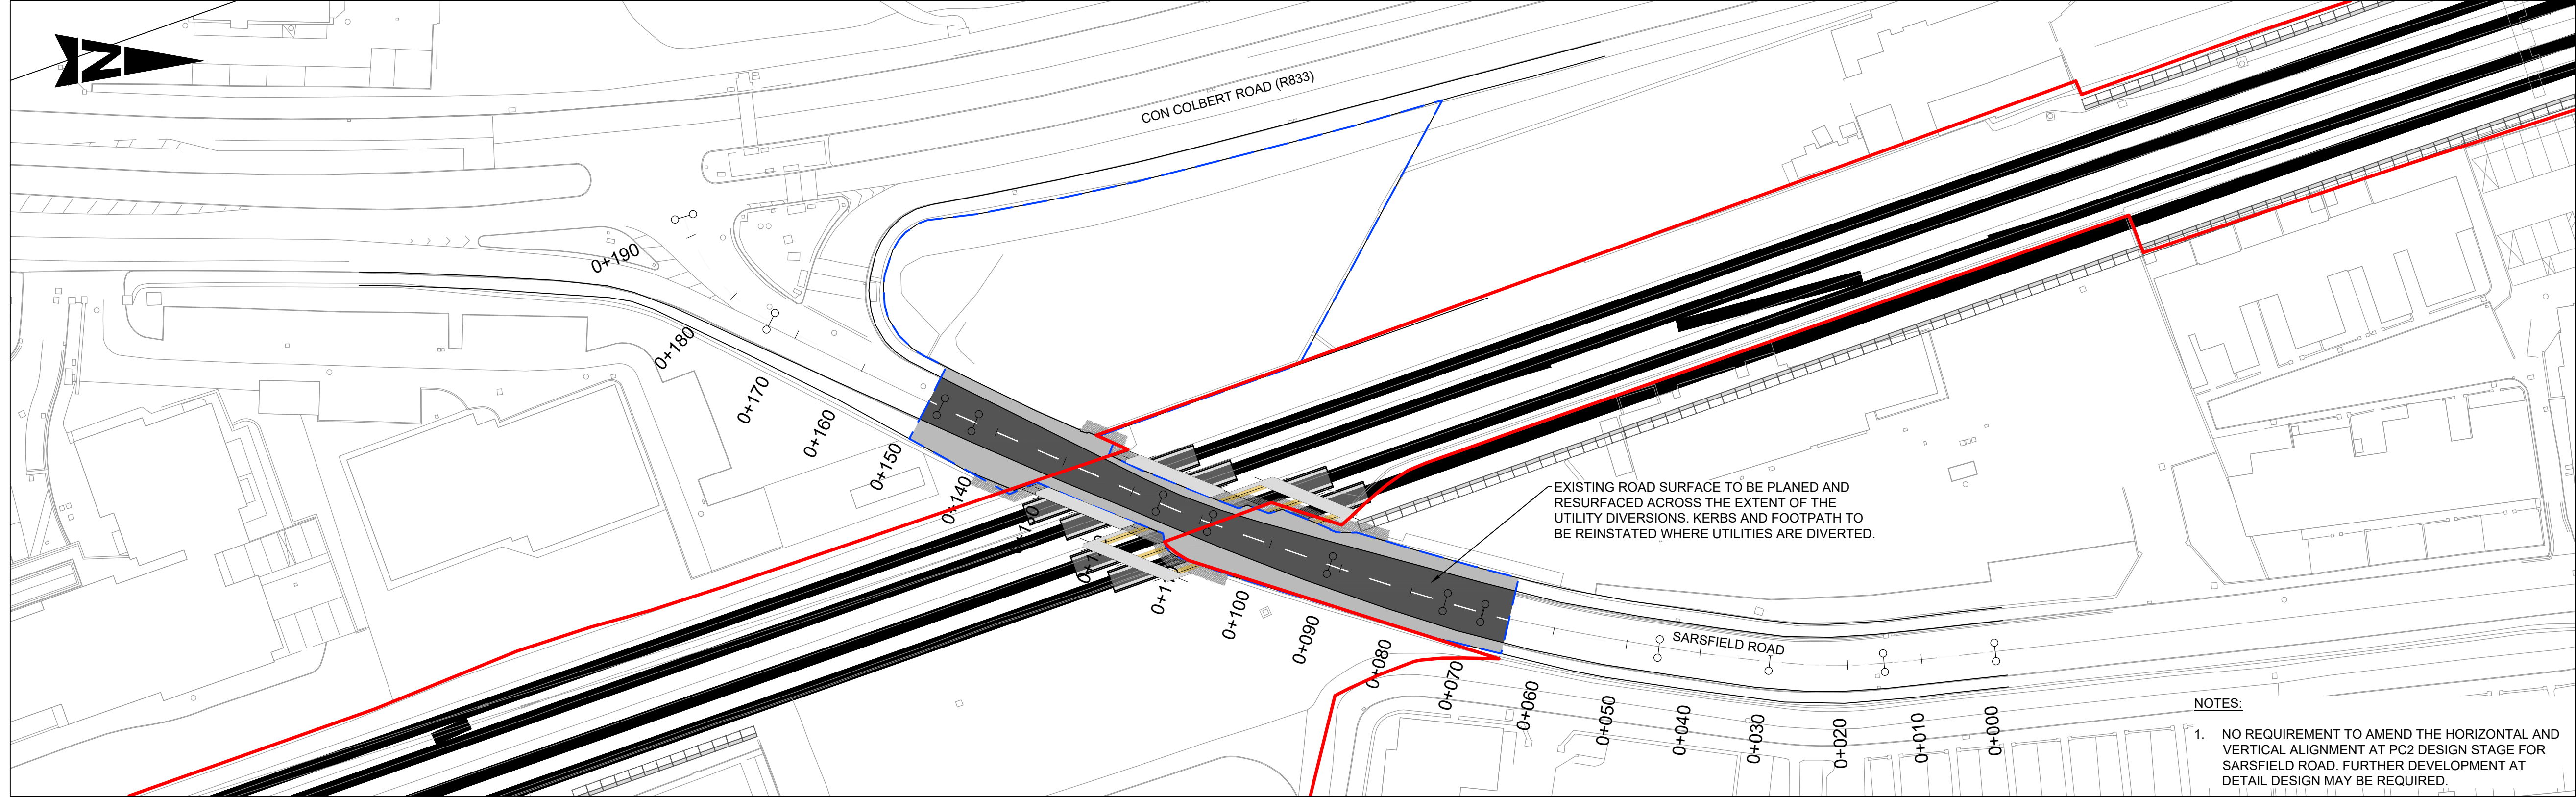
Rev	Date	Dm	Chk'd	App'd	Description
v01	29/10/21	AOS	RM	AG	ISSUED FOR PUBLIC CONSULTATION 2

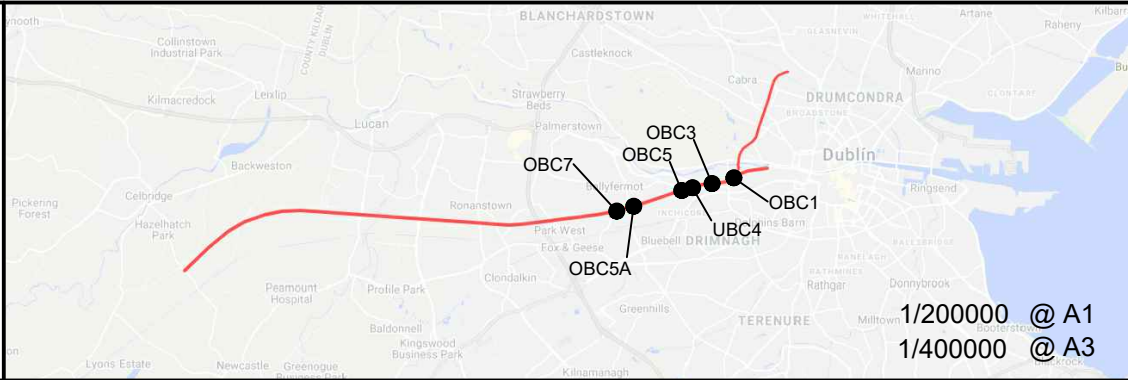Client	
Date	06/09/21
Project Code	5199586



Engineering Designer	
Supported by:	
Drawn	AOS
Checked	RM
Approved	AG
QMS Code	

Project Title	
DART + SOUTH WEST	
Drawing Title	
SARSFIELD ROAD BRIDGE (UBC4) BRIDGE DECKS CROSS SECTIONS	
Drawing File Name	DP-04-23-DWG-ST-TTA-57144
Version	v01
Status	S3

DO NOT SCALE USE FIGURED DIMENSIONS ONLY



PLAN - SARSFIELD ROAD - UNDERBRIDGE
SCALE 1:500

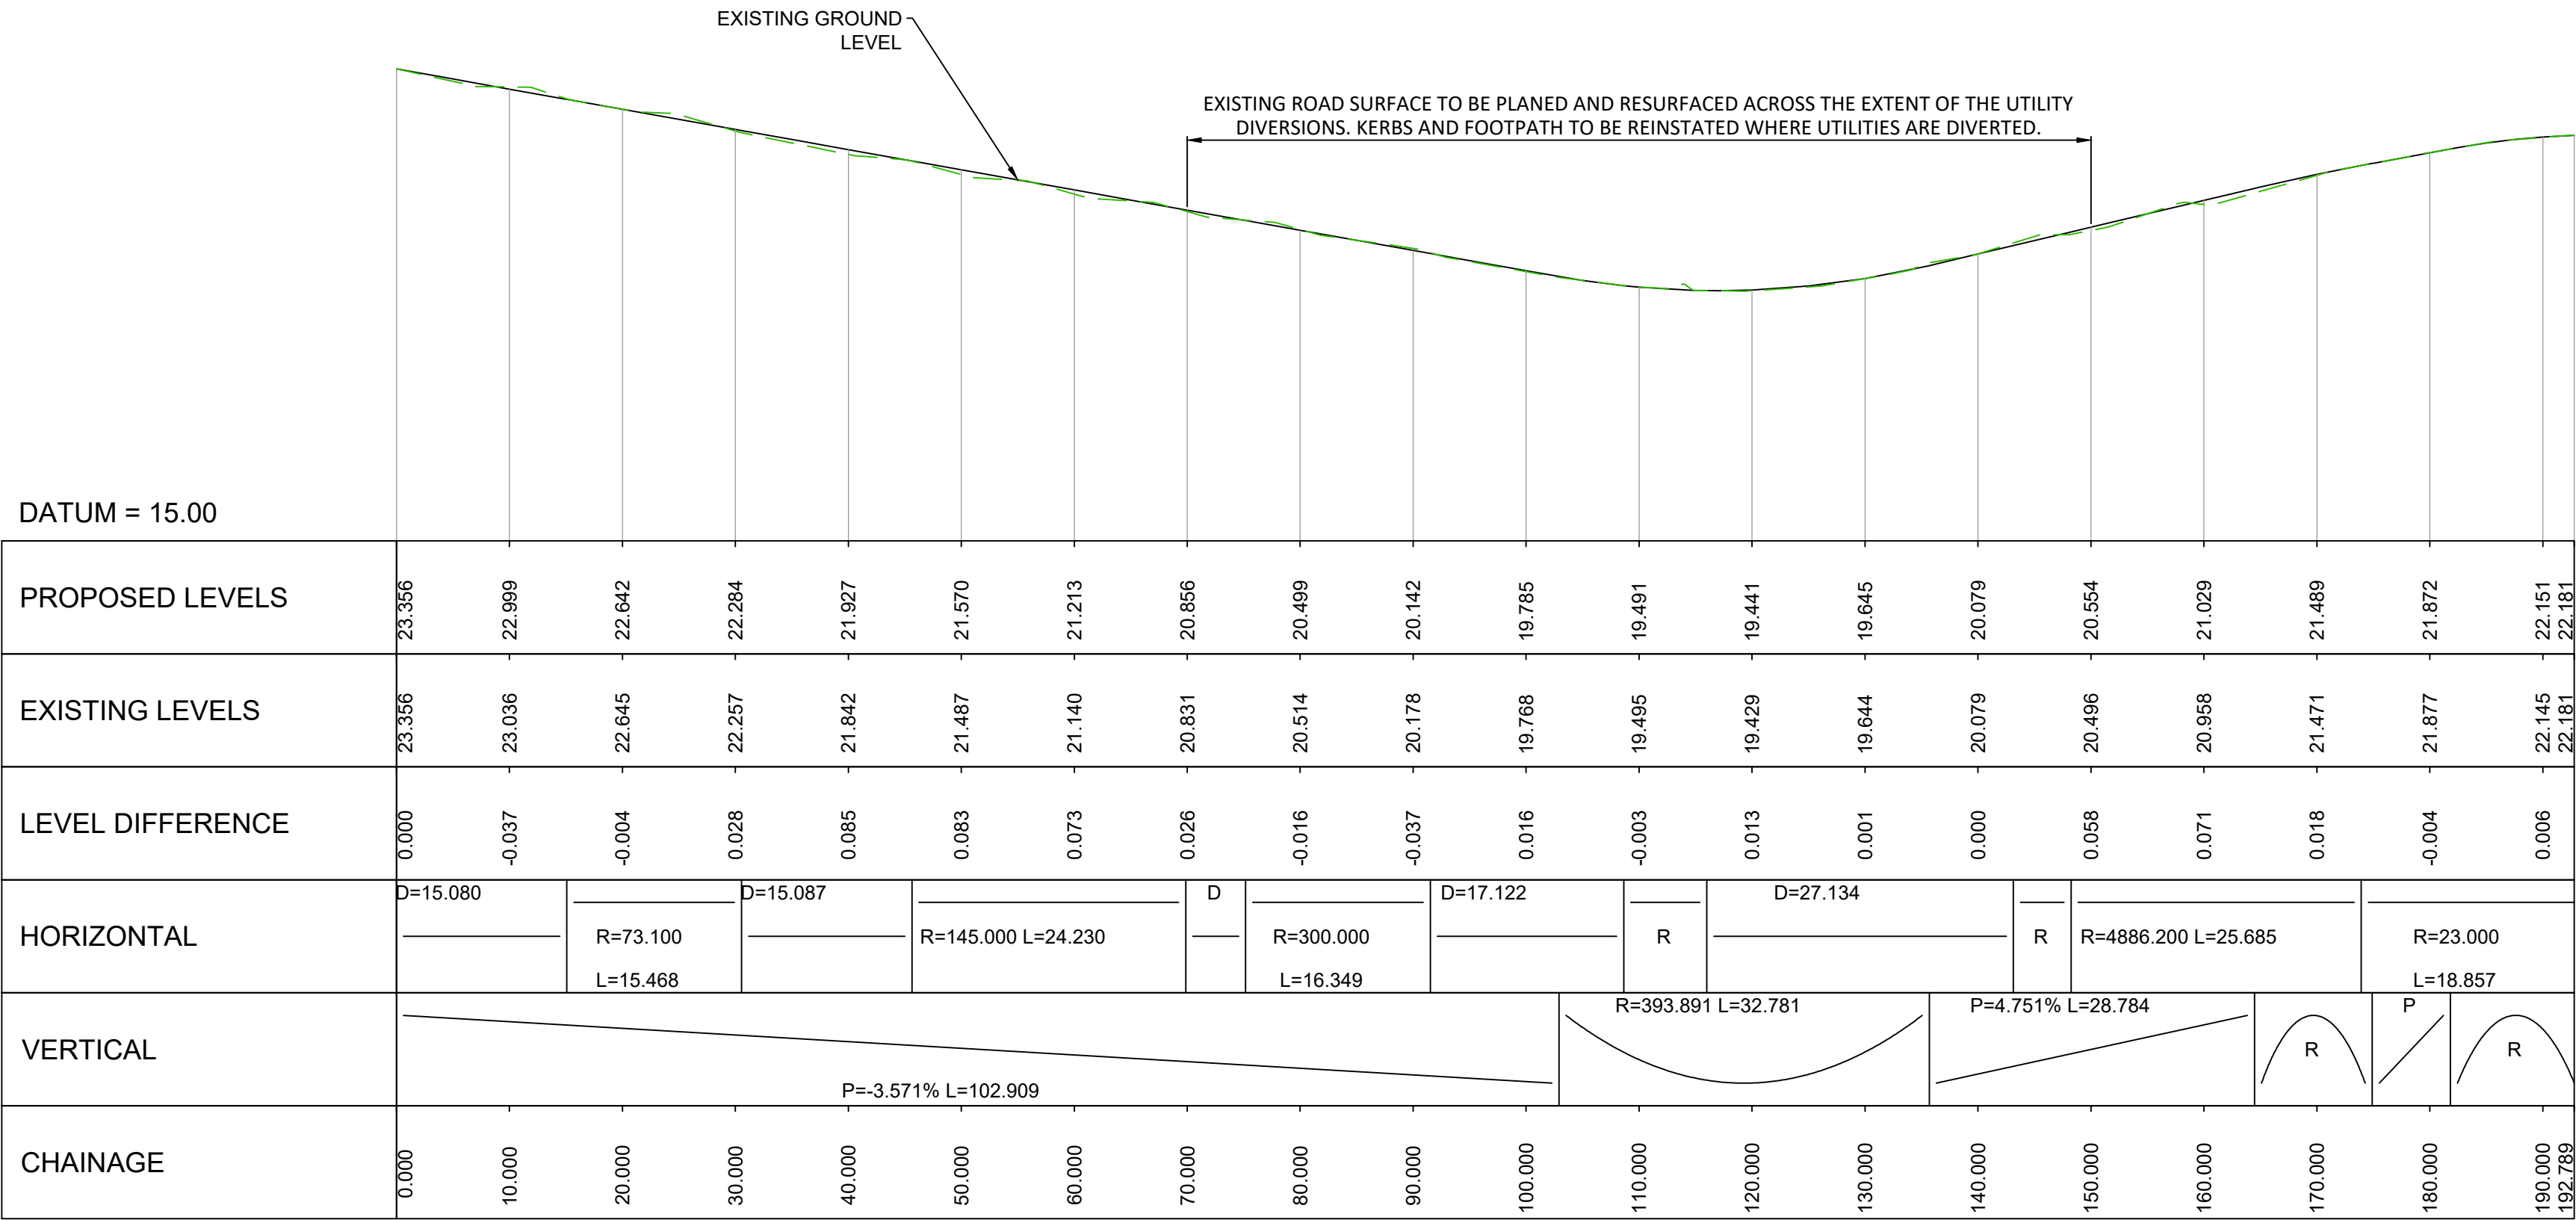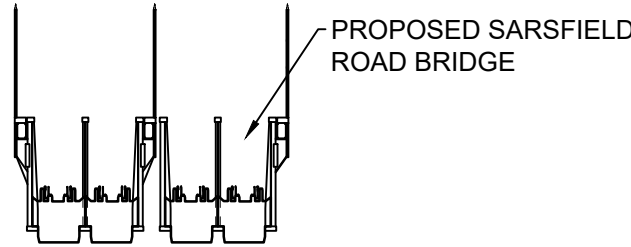


LONGITUDINAL SECTION - SARSFIELD ROAD BRIDGE
SCALE 1:500 Horizontal, 1:100 Vertical

- LEGEND:
- IRISH RAIL PROPERTY BOUNDARY
 - H4A CONTAINMENT
 - TEMPORARY WORKS BOUNDARY
 - CARRIAGEWAY
 - PROPOSED FOOTPATH
 - PROPOSED SHARED SPACE
 - PROPOSED RAISED CYCLE TRACK / LANE
 - PROPOSED ON ROAD CYCLE LANE
 - PROPOSED TACTILE PAVING (CONTROLLED)
 - PROPOSED TACTILE PAVING (UNCONTROLLED)
 - PROPOSED GRASS VERGE
 - EXISTING GRASS VERGE TO BE RETAINED
- NOTES:
- DO NOT SCALE FROM DRAWING.

U:\51995866 Dwg-Graphics\61 AutoCad\DP-04-23-DWG-CV-TTA-56511.dwg

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Rev	Date	Drm	Chk'd	App'd	Description
V01	28.10.21	DB	JX	DM	ISSUED FOR PUBLIC CONSULTATION 2

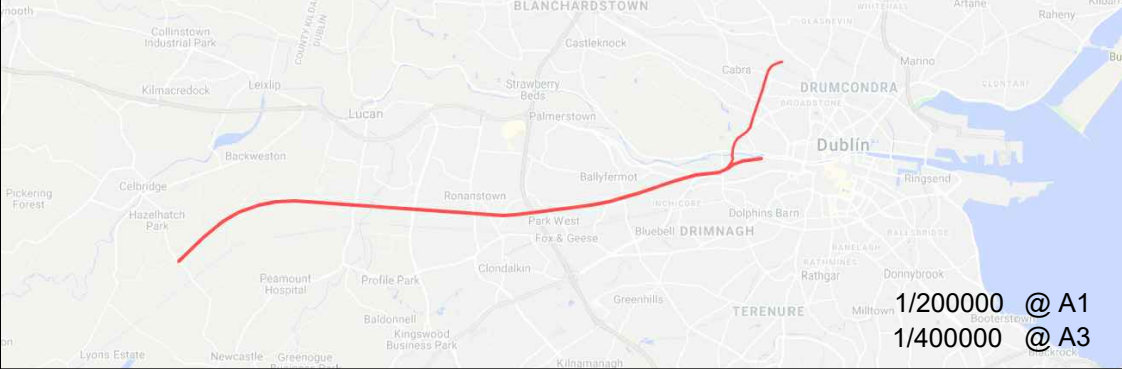Client
Iarnród Éireann
Irish Rail

Date: 01.10.21
Scale: AS SHOWN @ A3
Project Code: 5199586
Issuer: ATK


Engineering Designer
ATKINS
Supported by: **TYPSPA**
Drawn: DB
Checked: JX
Approved: DM

Project Title
DART + SOUTH WEST

Drawing Title
**SARSFIELD ROAD BRIDGE (UBC4)
ROAD - PLAN AND PROFILE**

Drawing File Name: DP-04-23-DWG-CV-TTA-56511
Version: V01
Status: S3

DO NOT SCALE USE FIGURED DIMENSIONS ONLY

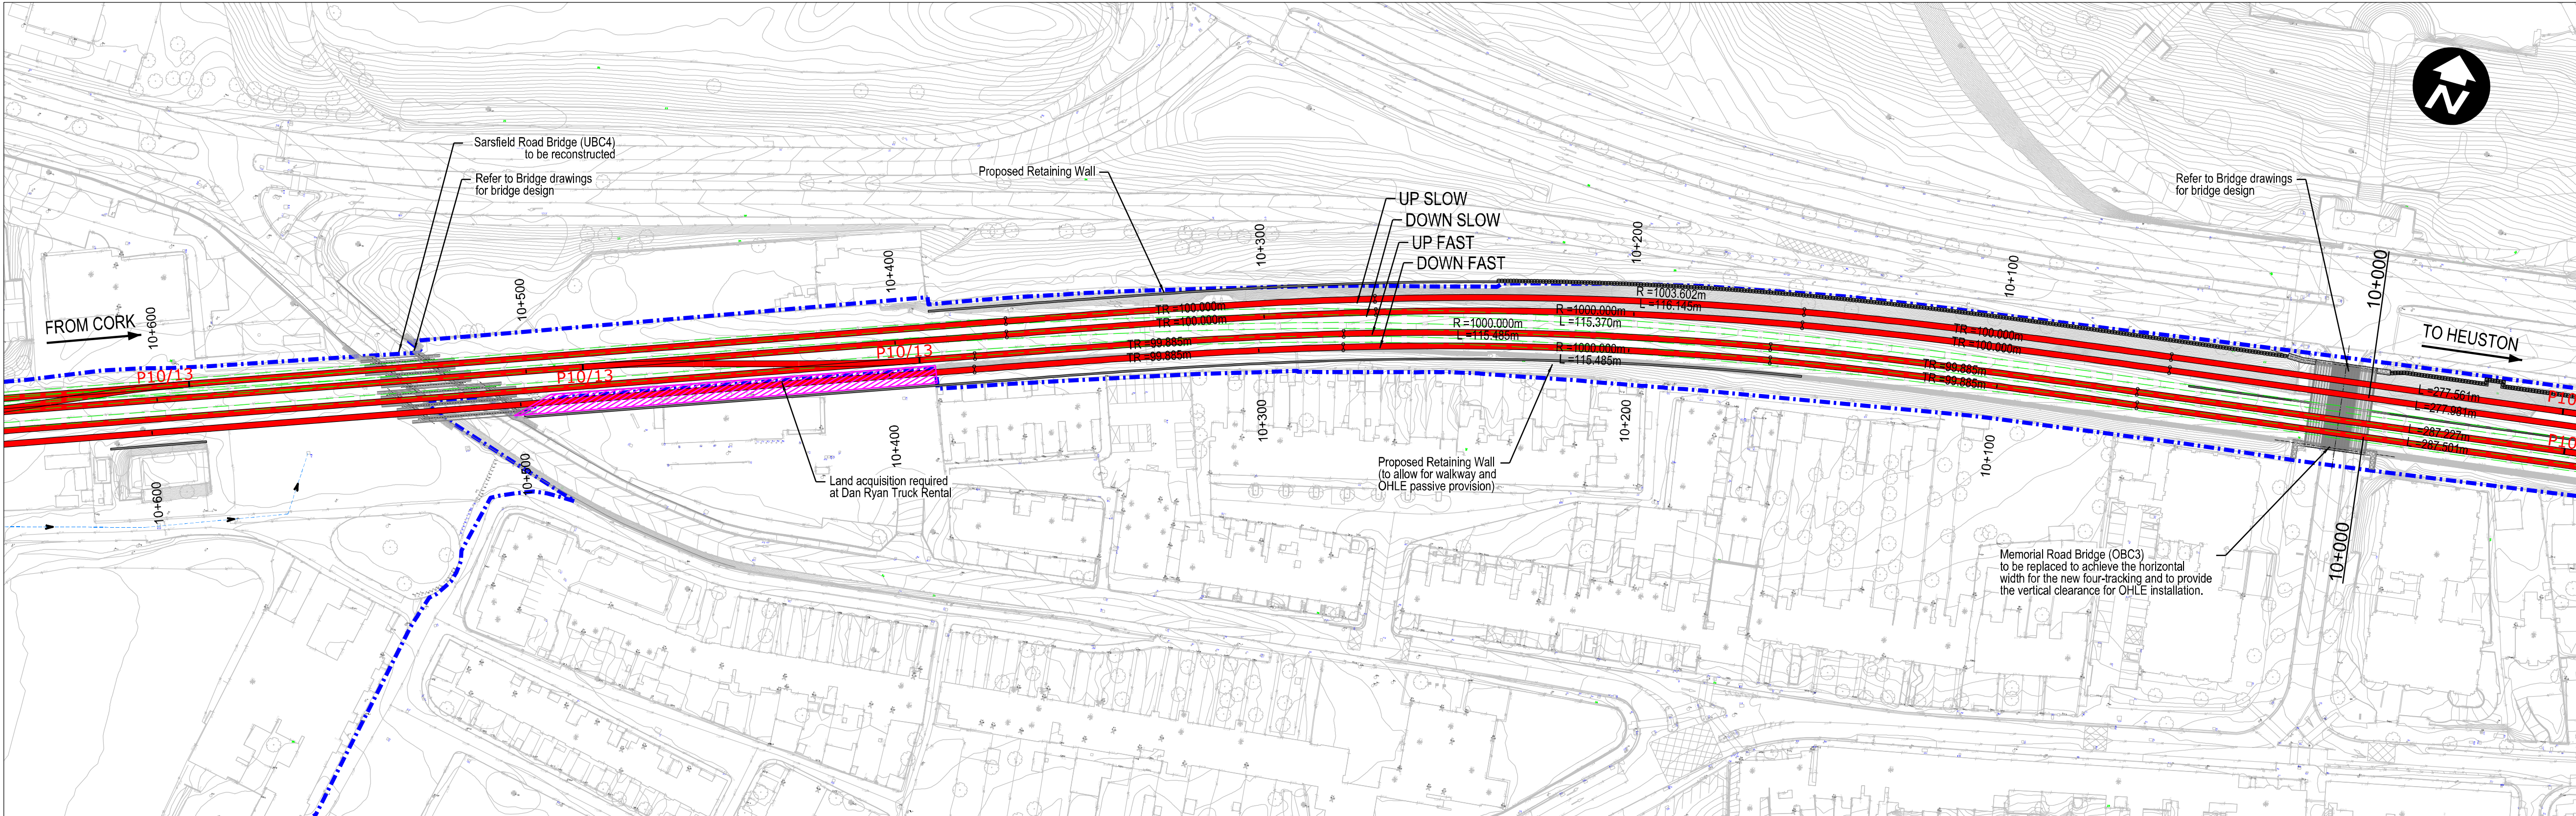

Plan View
Plan Scale 1:1000

Legend:

- Renewed Track / Slewbed Track
- Existing Track to be Retained (Main Lines)
- Existing Track to be Retained (Not Main Lines)
- Existing Track to be Removed
- IE Property Boundary
- Proposed Retaining Wall
- P8/8 Type of Turnout
- Low Voltage/Telecommunications/Signalling cabinets
- Indicative area of land acquisition required, based on available topographic survey information but not considering actual property boundary limits

1. Design is based on topographical survey OT-94577-Dart-Southwest Section_01 to 10 (DWG format) in ITM coordinates.
2. Slow tracks to be electrified.


NOTE:

INFORMATION IS PRESENTED FOR PUBLIC CONSULTATION NO.2

NOT ALL DESIGN DETAIL OR CONSTRUCTION RELATED DETAIL ARE KNOWN AT THIS TIME. E.G. SUBSTATION LOCATIONS, CONSTRUCTION COMPOUNDS, TEMPORARY BRIDGE REQUIREMENTS, TEMPORARY UTILITY DIVERSIONS AND OTHER ELEMENTS

POTENTIAL INTERFERENCE WITH PROPERTY RIGHTS IS BASED ON THE LEVEL OF INFORMATION AND DESIGN AVAILABLE AT THIS TIME. FURTHER WORK INCLUDING DETAILED DESIGN AND TECHNICAL AND CONSTRUCTION RELATED SOLUTIONS WILL SEEK TO MINIMISE POTENTIAL INTERFERENCE WITH PROPERTY RIGHTS

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Rev	Date	Dm	Chk'd	App'd	Description
v01	21/09/21	CDM	JYM	PR	ISSUED FOR PUBLIC CONSULTATION 2

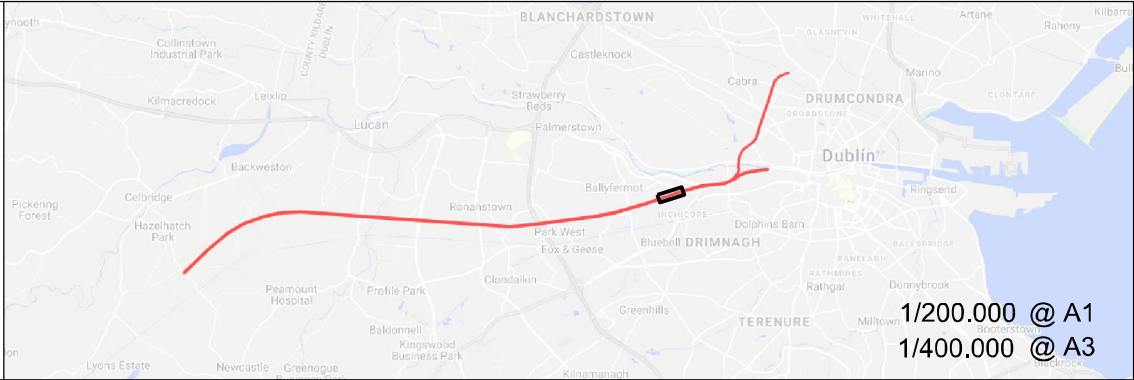Client

Engineering Designer

Supported by:

Date

Scale 1:1000 @ A1
1:2000 @ A3

Project Code

Issuer ATK

Drawn

Checked

Approved

CDM

JYM

PR

QMS Code

Project Title

DART + SOUTH WEST

Drawing Title

SARSFIELD ROAD BRIDGE (UBC4) AND
MEMORIAL ROAD BRIDGE (OBC3)
TRACK PLAN LAYOUT

Drawing File Name

DP-04-23-DWG-PW-TTA-56995

Version

Status

v01

S3

